

Borough of Chambersburg

A full service municipality in Franklin County celebrating over 65 years of consumer owned natural gas service over 120 years of community electric and a regional wastewater, water, and municipal solid waste utility

March 25, 2025

ADDENDUM NO. 1

To the Contract Documents for Conococheague Creek Canoe/Kayak Launch and Fishing Dock Project For The Borough of Chambersburg, PA

In accordance with the requirements of the "Instructions to Bidders", this Addendum shall be attached to and become a part of the Contract Documents for the above referenced project.

1. Revised Plans and Specifications:


Please find the revised plans and specifications attached to this Addendum

• Plans/specifications have been revised to show modifications at the center of the dock for a wheel chair with a lower height rail and an opening for the foot rest to project beyond the rail. Sheet S1.1 has been revised.

2. Further clarification:

- Pages 181-184 of the bid document are attachments that were included with the original Grant Agreement with the PA Fish and Boat Commission. These attachments do not accurately reflect the 'current' scope of work AND project location.
- Amendment #1 was approved by the PA Fish and Boat Commission. This Amendment allowed for the completion of the project by December 31, 2025.

END OF ADDENDUM NO.1

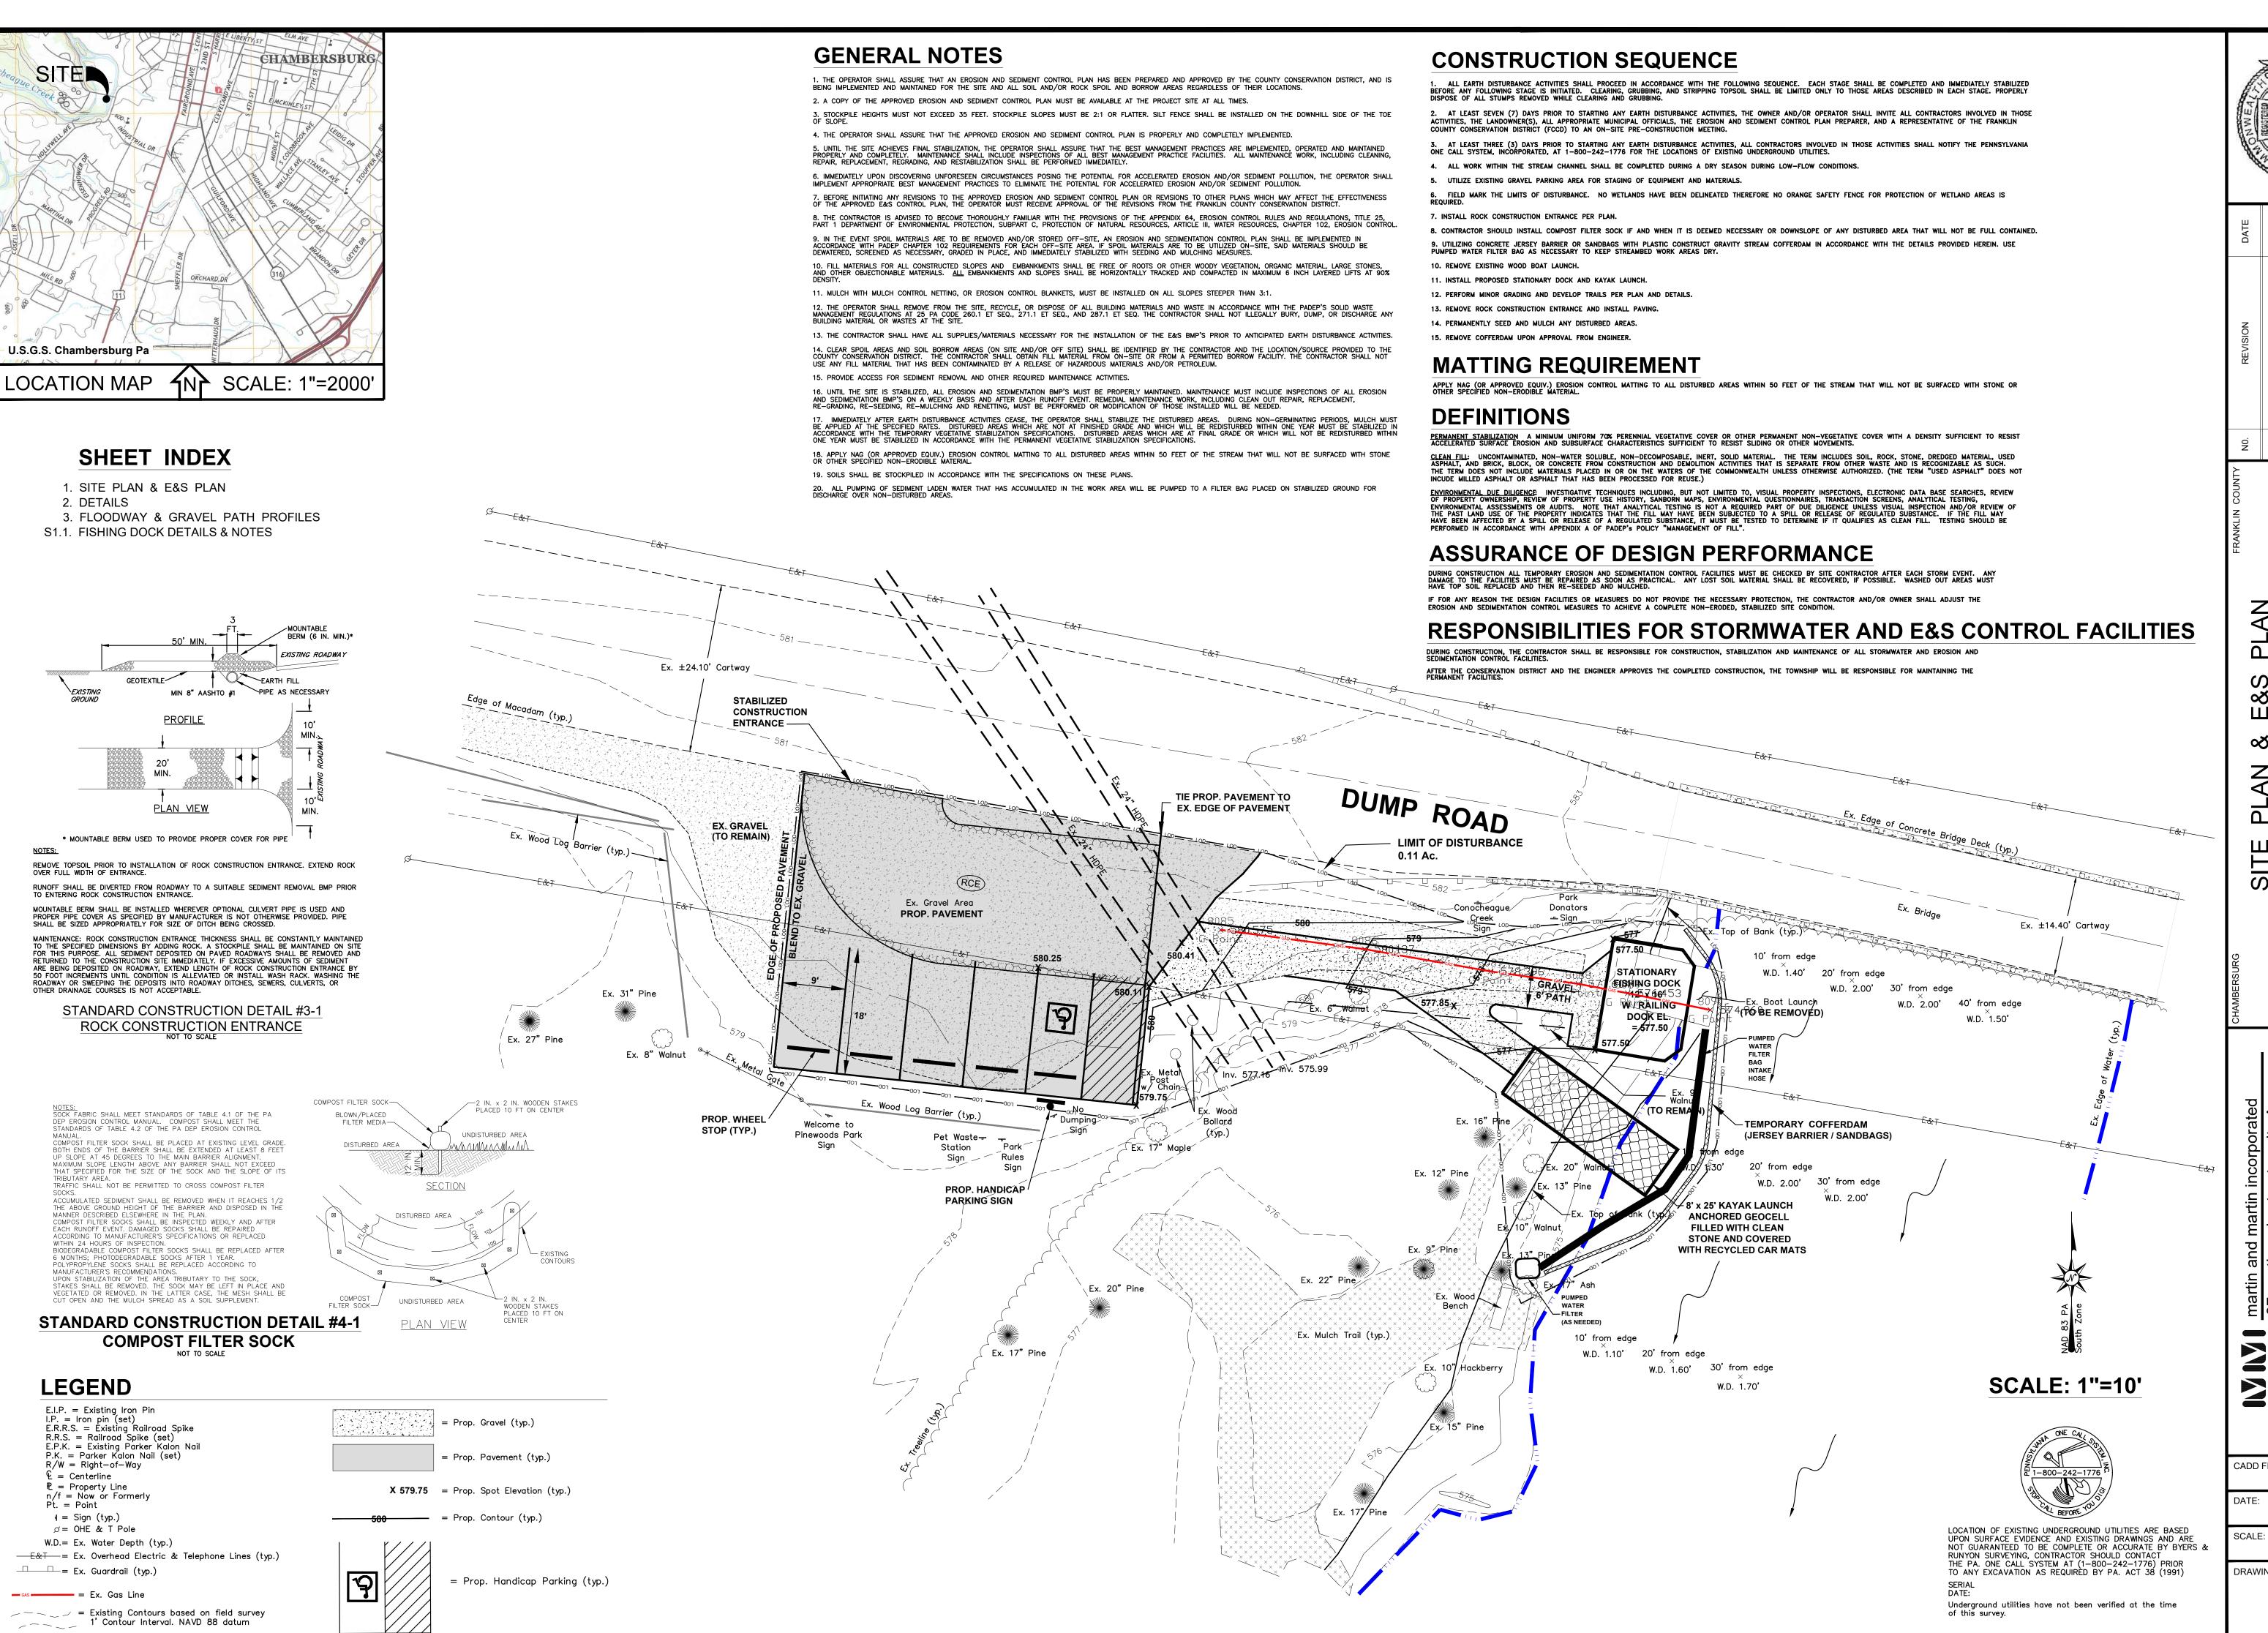

7 2 8

П 1 CHAM ISHING S

20 17


 \geq


CADD FILE: 1816-01.dwg

DATE: 06/17/24

1"=10' DRAWING NO.

1 of 4

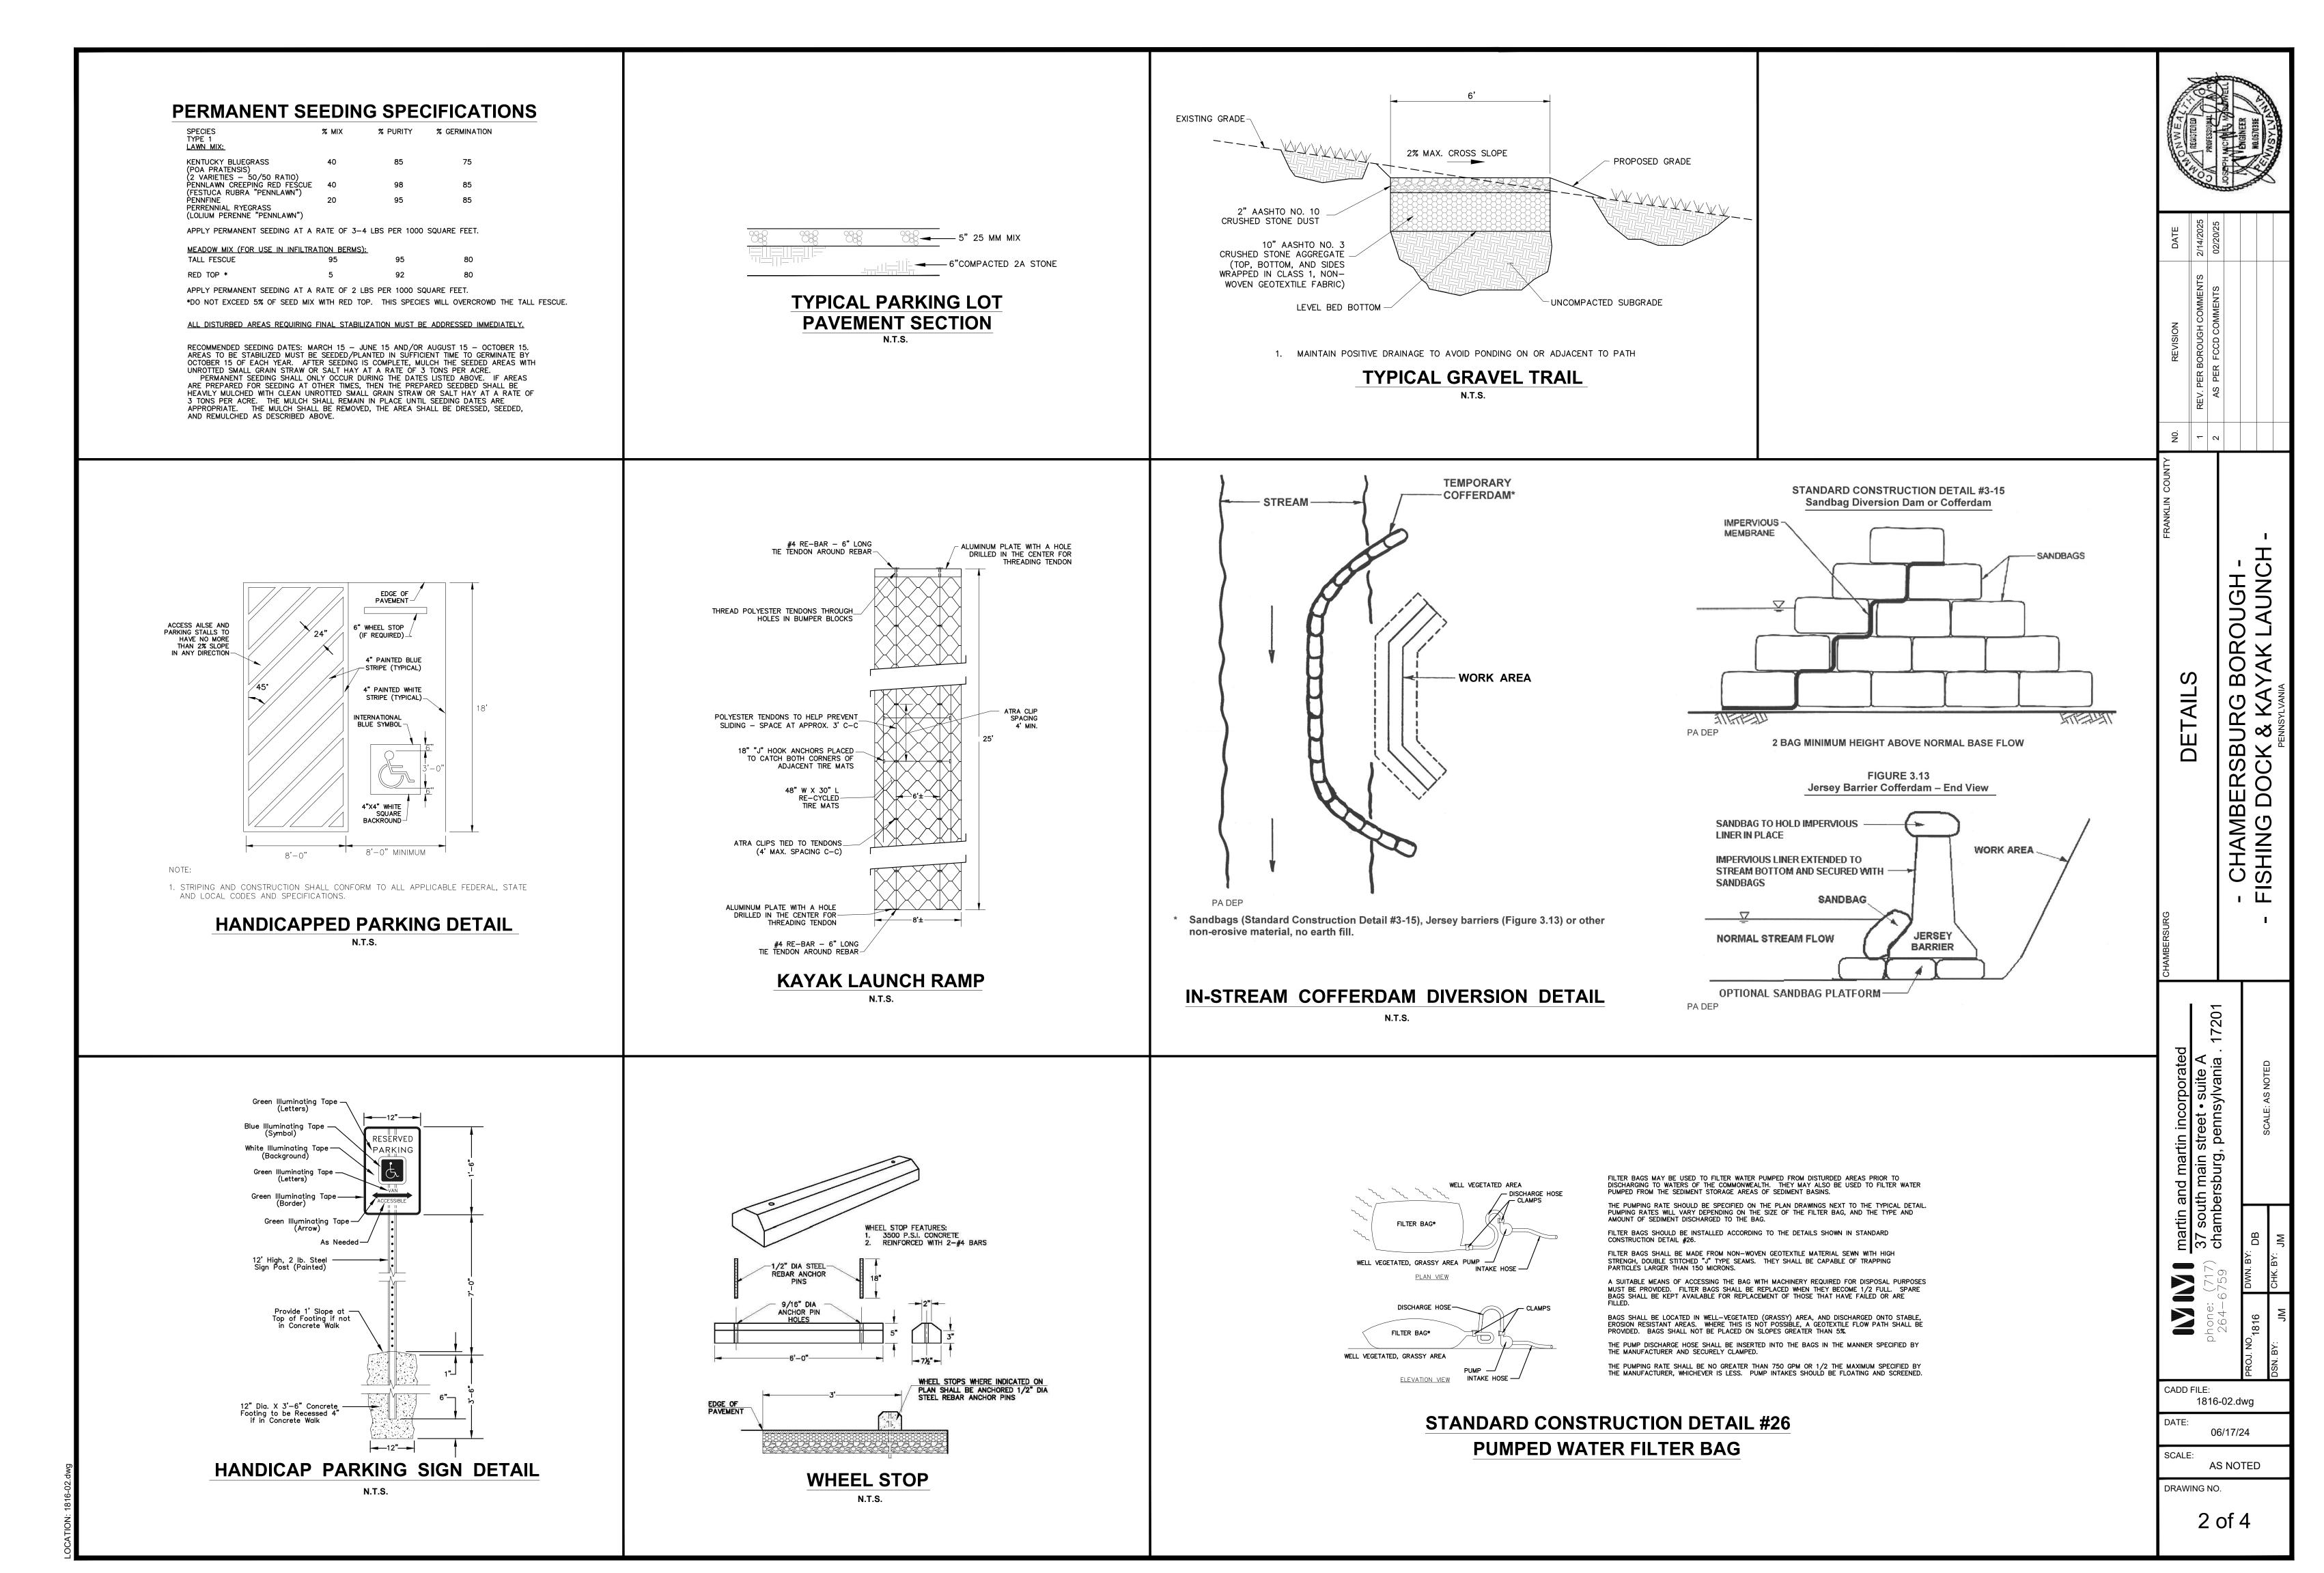

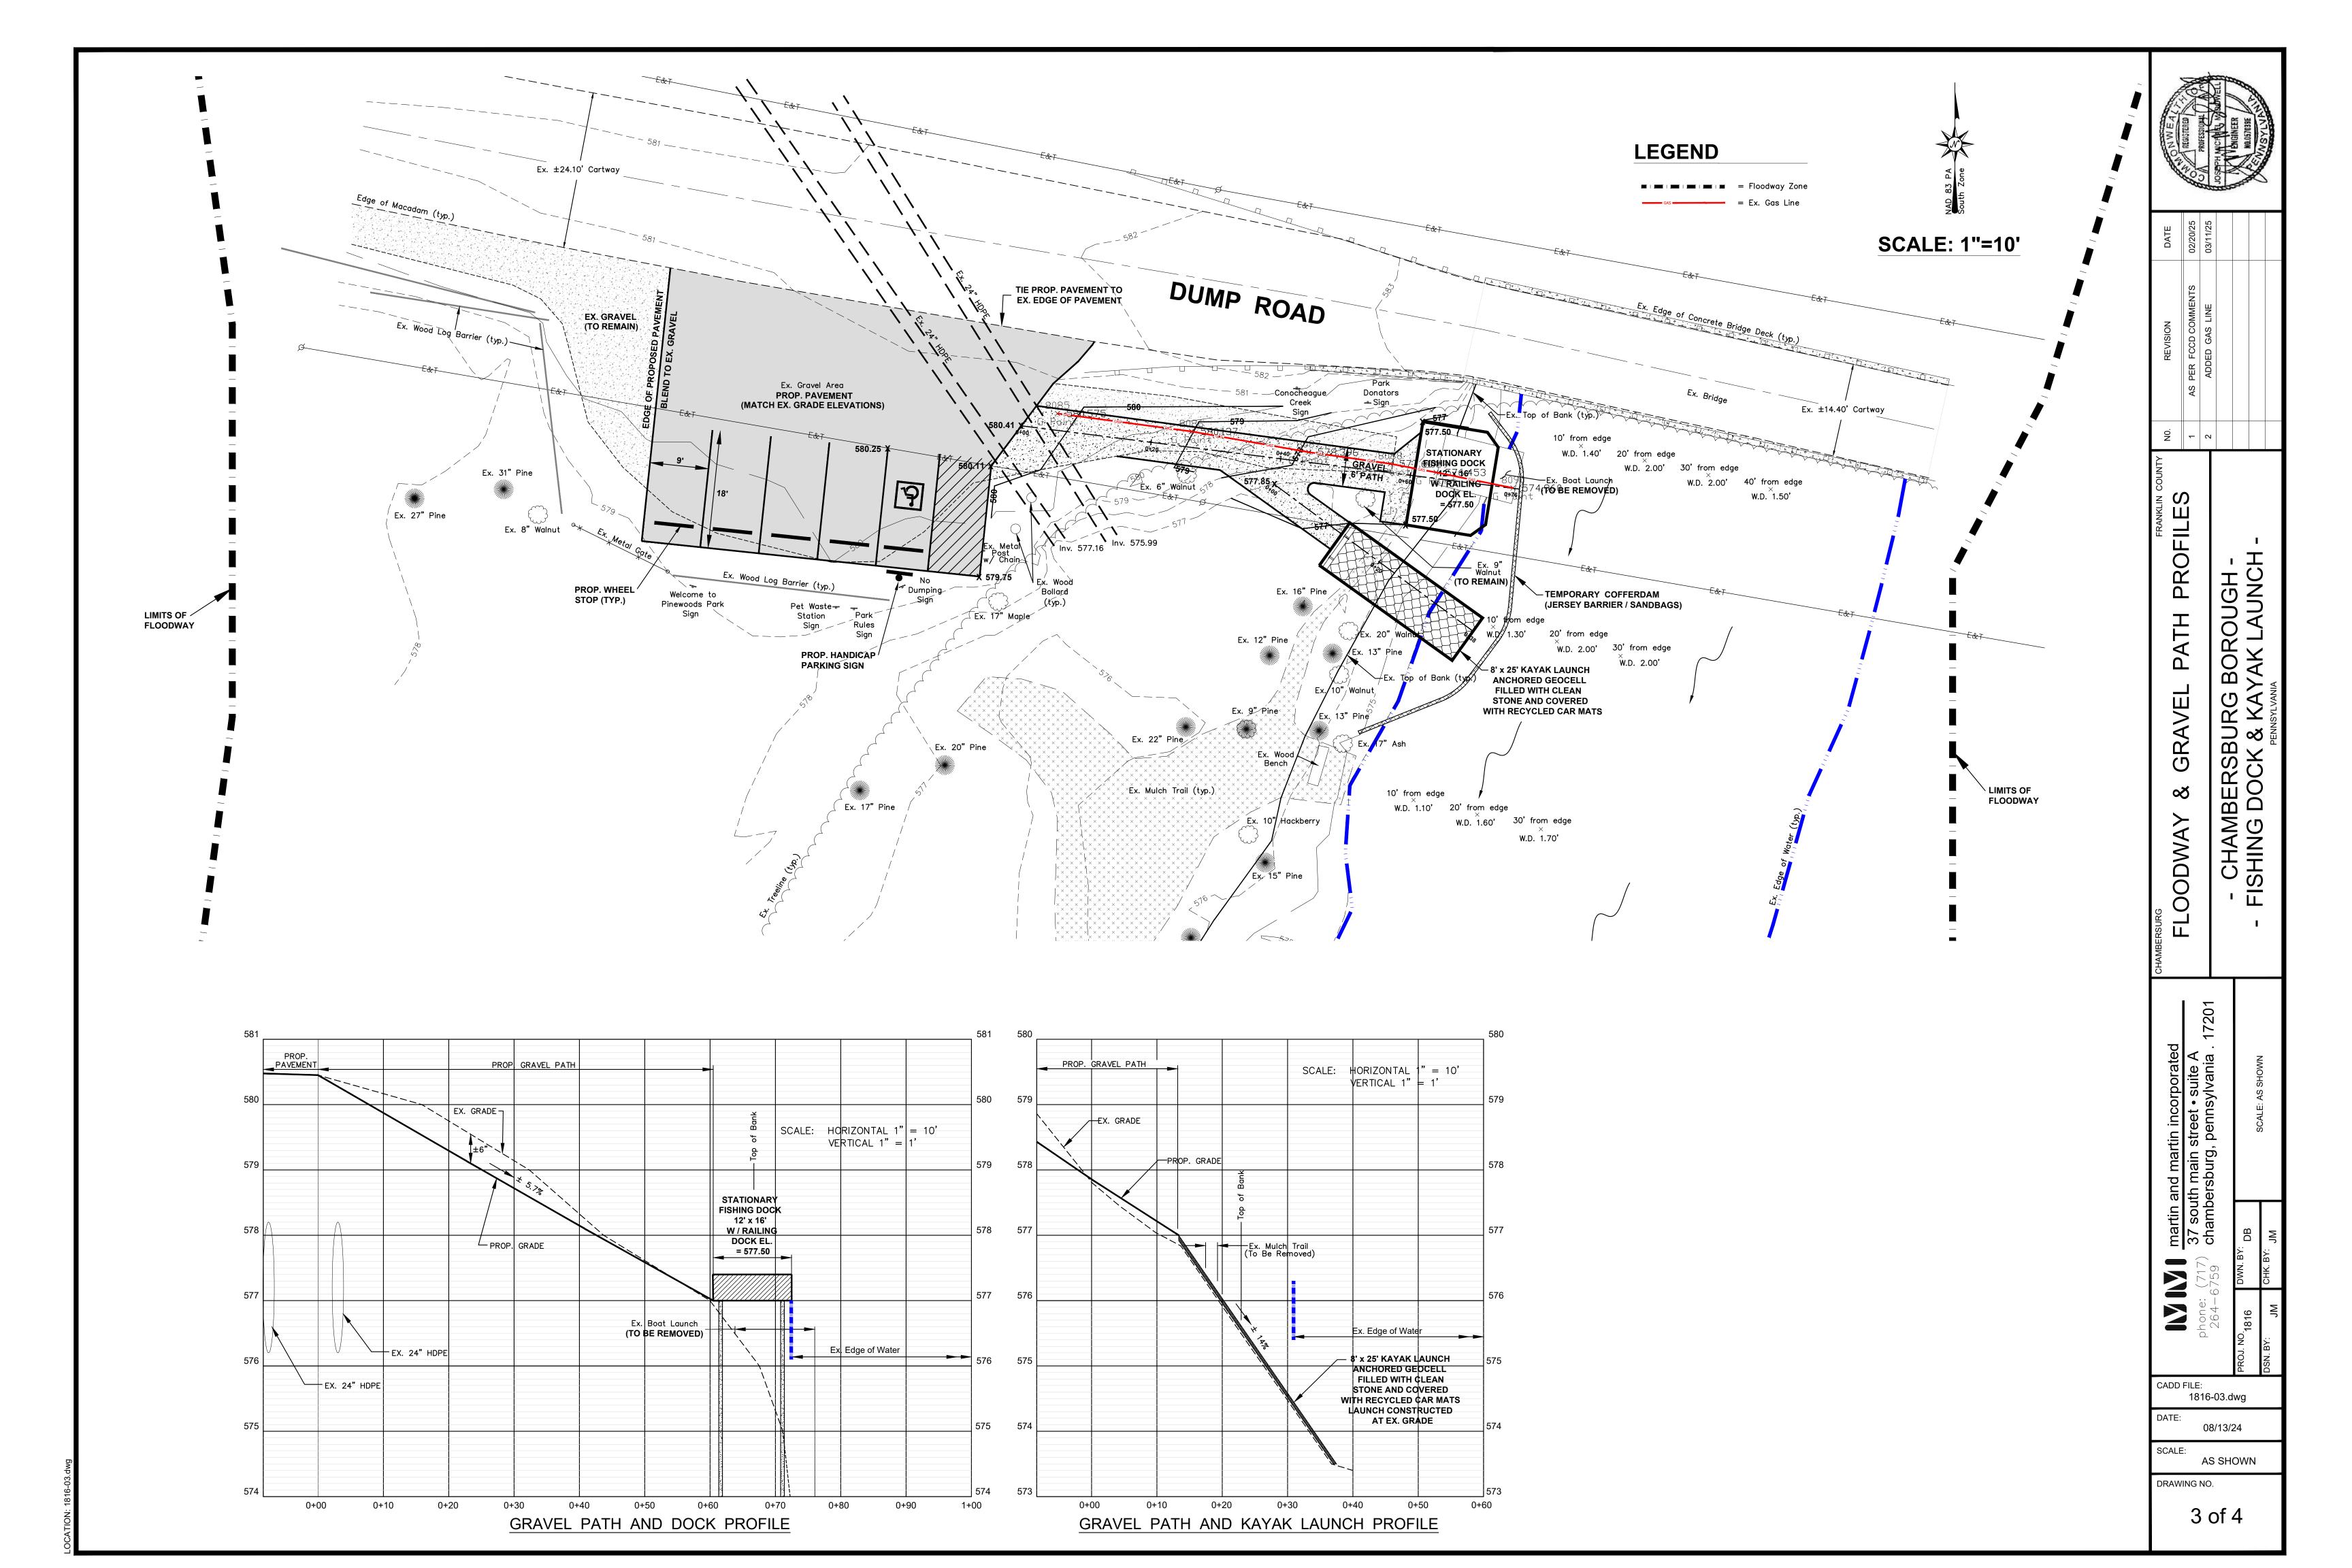

DESIGN CRITERIA

- I. GOVERNING CODES:
 - INTERNATIONAL BUILDING CODE, 2018 ASCE 7 - 2016
- 2. DESIGN LIVE LOADS: 100 PSF

FOUNDATION PLAN NOTES

- I. COORDINATE ALL DIMENSIONS AND DETAILS WITH THE DRAWINGS AND DETAILS.
- 2. ALL FOOTING ELEVATIONS ARE INDICATED ON THE PLANS AND ARE GIVEN AS A DISTANCE RELATIVE TO THE TOP OR BOTTOM OF THE REFERENCE ELEVATION.
- 3. ENGINEER TO EXAMINE FOUNDATION SUBGRADES IN THE FIELD. PROOF-ROLL THE EXPOSED SUBGRADE. OVER-EXCAVATE AND RE-FILL ALL EXPOSED SOFT AREAS OR OTHER IRREGULARITIES ENCOUNTERED AS DIRECTED BY THE ENGINEER.
- 4. ALL STRUCTURAL FILL MATERIAL TO BE APPROVED BY ENGINEER.
- COMPACT ALL FILL AND BACKFILL PLACED IN STRUCTURAL AREAS OF THE BUILDING, INCLUDING THE AGGREGATE CUSHIONS UNDER FOOTINGS AND FLOOR SLABS, USING LOOSE 8" THICK LIFTS, TO AT LEAST 100% OF THE MAXIMUM DRY DENSITY AT WITHIN PLUS OR MINUS 3% OF THE OPTIMUM MOISTURE CONTENT AS DETERMINED BY THE STANDARD COMPACTION TEST, ASTM D 698.
- WHERE BEDROCK IS ENCOUNTERED AT THE FOOTING OR SLAB SUBGRADE LEVELS, REMOVE AND UNDERCUT GRADE A MINIMUM OF 12" BELOW FOOTINGS AND 12" BELOW SLABS. BACKFILL UNDERCUT AREAS WITH A CUSHION LAYER OF CRUSHED AGGRE-GATE, PLACED AND COMPACTED AS SPECIFIED. MANUALLY PROBE ALL FOOTING SUBGRADES TO ENSURE THAT NO BEDROCK IS PRESENT WITHIN 12" OF THE PROPOSED BASE LEVELS. IF BED-ROCK IS PRESENT WITHIN THIS DEPTH, FOLLOW THE PROCEDURE DEFINED ABOVE.
- 7. FOUNDATION DESIGN IS BASED ON A NET ALLOWABLE BEARING CAPACITY OF 2000 PSF.
- 8. (*) DESIGNATES DIMENSIONS TO BE VERIFIED IN THE FIELD BY GENERAL CONTRACTOR.

CONCRETE NOTES


- I. ALL CONCRETE WORK SHALL CONFORM TO ALL REQUIREMENTS OF ACI 301 SPECIFICATIONS FOR STRUCTURAL CONCRETE BUILDINGS, EXCEPT AS MODIFIED BY THE FOLLOWING SUPPLEMENTAL REQUIREMENTS.
- 2. ALL CONCRETE SHALL HAVE THE FOLLOWING 28 DAY COMPRESSIVE STRENGTHS:
- A. ALL CONCRETE FOR FOUNDATIONS SHALL BE NORMAL WEIGHT WITH A COMPRESSIVE STRENGTH OF F'C = 4000PSI.
- B. ALL EXTERIOR CONCRETE FOR WALLS AND PIERS SHALL BE NORMAL WEIGHT WITH A COMPRESSIVE STRENGTH OF F'C = 5000 PSI,
- B. A CONCRETE ADDITIVE SUCH AS A SUPER PLASTISIZER MAY BE NORMAL WEIGHT WITH A COMPRESSIVE STRENGTH OF F'C = 5000 PSI,
- 3. ALL REINFORCING STEEL SHALL BE DEFORMED BARS CONFORMING TO ASTM A615, GRADE 60.
- 4. MINIMUM CONCRETE PROTECTION FOR REINFORCING (EXCEPT AS OTHERWISE NOTED) SHALL CONFORM TO THE PROVISIONS OF ACI 301.
- SPLICING OF REINFORCEMENT, EXCEPT AS SHOWN IN THE DRAWINGS, IS NOT PERMITTED UNLESS SPECIFICALLY APPROVED BY THE ENGINEER. UNLESS OTHERWISE SHOWN IN THE DRAWINGS, THE TYPICAL SPLICE LENGTHS SHALL BE AS FOLLOWS:
- #4 L = 20" #5 L = 25" #6 L = 31" #7 L = 39"
- 6. DETAILING OF ALL REINFORCING STEEL SHALL CONFORM TO "ACI MANUAL OF STANDARD PRACTICE FOR DETAILING REINFORCED CONCRETE STRUCTURES" (ACI315).
- 7. PROVIDE CORNER REINFORCING WITH REQUIRED LAP SPLICE LENGTHS AT ALL CORNERS AND INTERSECTIONS OF FOOTINGS AND WALLS.


EXCAVATION + GRADING NOTES

- I. ALL CONSTRUCTION OPERATIONS SHALL BE CARRIED OUT IN SUCH A MANNER SO THAT EROSION AND AIR AND WATER POLLUTION WILL BE MINIMIZED. DISTURBING OF THE NATURAL VEGETATION ALONG THE STREAM TO BE MINIMIZED. THE WORK AREA SHALL BE LIMITED TO THE IMMEDIATE AREA ADJACENT TO THE
- 2. EXCAVATED MATERIAL SHALL BE PLACED, WHEN PRACTICAL, ON THE UP SLOPE SIDE OF TEH EXCAVATION TO RETARD THE EROSION OF SOIL. BACKFILL MATERIAL SHALL BE COMPACTED IN ACCORDANCE WITH SPECIFICATIONS AND DISTURBED SURFACES RETURNED TO ORIGINAL GRADE. ALL VEGETATION SHALL BE RE-ESTABLISHED. CARE MUST BE TAKEN ON ANY SLOPED AREAS TO DIVERT RUNOFF BY USING STRAW BALES OR OTHER SUITABLE MEANS.
- 3. UPON COMPLETION OF THE CONSTRUCTION, ALL BANKS, STREAM BED AND DISTURBED AREAS SHALL BE RETURNED TO ITS ORIGINAL CONDITION... ALL DISTURBED AREAS SHALL BE PROTECTED AGAINST SOIL EROSION BY SEEDING
- 4. SANDBAGS SHALL BE USED TO TEMPORARILLY DIVERT STREAM WITH A MINIMUM A MINIMUM 10 MIL POLY SHEETING COVER. TEMPORARY DEWATERING SHALL BE PUMPED TO AN ISOLATION AREA SURROUNDED BY STRAW BALES.

WOOD FRAMING NOTES

- I. THE LIGHT FRAMED WOOD CONSTRUCTION SHALL COMPLY WITH SECTION 2303 OF IBC AND AMERICAN FOREST AND PAPER ASSOCIATION WOOD FRAME CONSTRUCTION MANUAL FOR ONE AND TWO FAMILY DWELLINGS.
- 2. WOOD FRAMING SHALL BE PRESSURE TREATED #2 YELLOW PINE.
- 3. WOOD DECKING SHALL BE PRESSURE TREATED #2 YELLOW PINE.
- 4. WOOD PLANKING WEARING SURFACE SHALL BE ROUGH SAWN #2 RED OAK OR APPROVED EQUAL WITH SIS AND S2E.
- 5 EACH WOOD DECK MEMBER SHALL BE SCREWED TO EACH SUPPORT BEAM WITH TWO FLAT HEAD, 3" LONG STAINLESS STEEL SCREWS' THE WOOD WEARING DECK SHALL BE ATTACHED TO THE WOOD DECK BELOW WITH TWO FLAT HEAD, 3" LONG STAINLESS STEEL SCREWS AT 24" OC.
- 6. BUTT JOINTS IN THE WOOD DECK AND THE WEARING DECK SHALL BE STAGGERED A MINIMUM OF 3' FOR ADJACENT MEMBERS.
- 7. ALL METAL FASTENERS INCLUDING BOLTS AND LAG SCREWS SHALL STAINLESS STEEL WITH A MINIMUM TENSILE YIELD STRENGTH OF 33.0 KSI.
- 8. ALL METAL HARDWARE FASTENERS SHALL BE STAINLESS STEEL AS MANUFACTURED BY SIMPSON STRONG-TIE OR APPROVED EQUAL WITH INSTALLATION PER MANUFACTURERS REQUIREMENTS.
- 9. WOOD PRESERVATIVE TREATMENT (P.T.) SHALL BE PRESSURE IMPREGNATED WITH WOOD PRESERVATIVE IN ACCORDANCE WITH AASHTO MISS AND CERTIFIED FOR. HEAVY DUTY GROUND CONTACT (UC4B). CUTTING AFTER PRESERVATIVE TREATMENT, THE EXPOSED WOOD SHALL BE TREATED WITH THE REQUIREMENTS OF AASHTO MI33.

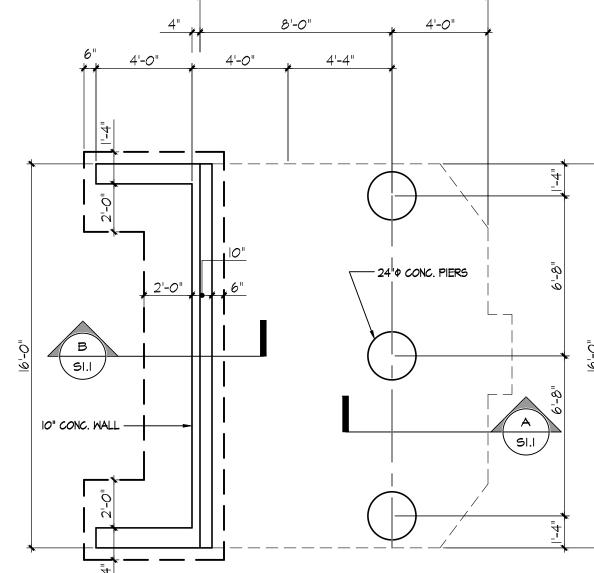

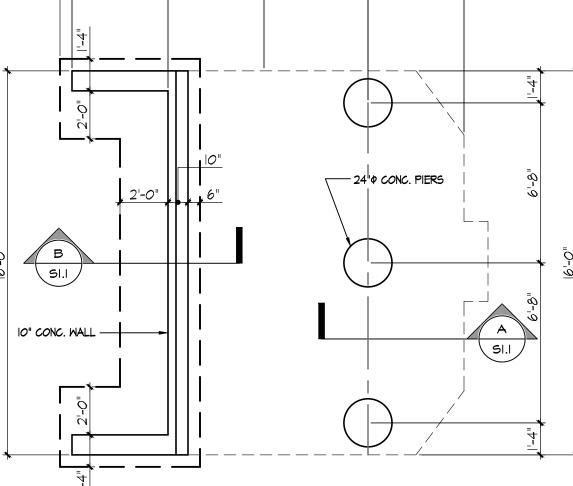



- 42" WOOD RAILING — 24" ONC. PIERS SI.I — 2 X 8₁0AK DECK ⁻ 10" CONC. WALL -

12'-0"

DRAWING TITLE

PROJECT NO.

MAR 24, 2025

REVISION DATE

ISSUE DATE

ALL DOCUMENTS PREPARED B DAVID BLACK ASSOCIATES, INC ARE INSTRUMENTS OF SERVICE WITH RESPECT TO THIS PROJEC

THEY ARE NOT INTENDED OR REPRESENTED TO BE SUITABLE FOR REUSE BY OWNERS, CONTRACTORS, OR OTHERS C

EXTENSIONS OF THIS PROJECT

OR ON ANY OTHER PROJECT.

ANY REUSE WITHOUT WRITTE

VERIFICATION OR ADAPTION B

DAVID BLACK ASSOCIATES, INC

WILL BE AT THE OWNERS SOLE

RISK AND WITHOUT LIABILITY

BLACK ASSOCIATES, INC. THE

ASSOCIATES, INC. FROM ALL

CLAIMS, DAMAGES, LOSSES AND

EXPENSES ARISING OUT OF OR

David Black Associates, Inc

David Black Associates

Engineers, Inc.

(717) 267-0202

(717) 267-3646 Fax

info@dba-ae.com

501 Lincoln Way East

Chambersburg, PA 17201

CHAMBERSBUR FISHING DOCK & K CHAMBERSBURG,

RESULTING THEREFROM.

OWNER SHALL INDEMNIFY AND


HOLD HARMLESS, DAVID BLACK

OR LEGAL EXPOSURE TO DAVID

STREAM DECK + FOUNDATION PLANS, ELEVATIONS, DETAILS + NOTES

24091

SHEET NUMBER

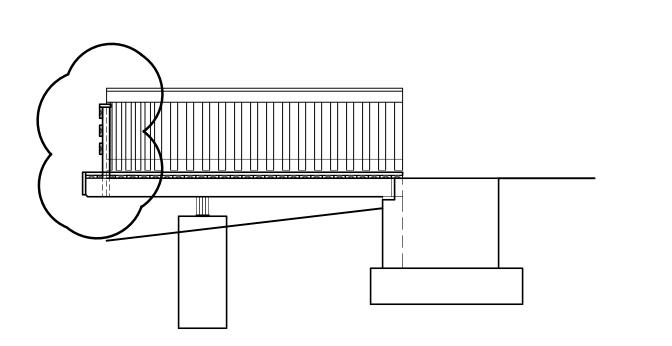



P.T. 2 X 4 SUPPORT— BLOCKING


_2 X 10 P.T.

DETAIL

SCALE 3/4" = 1'-0"

– P.T. 2 X 6

— P.T. 2 X I2

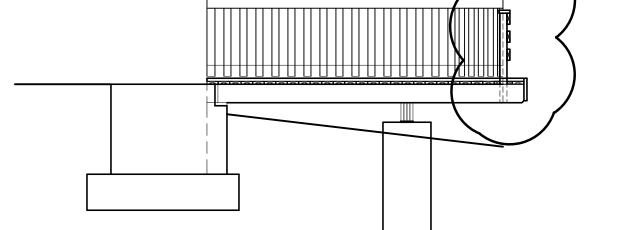

ELEVATION SCALE 1/4" = 1'-0"

___ P.T. 2 X 6


— P.T. 2 X 6


2 - 2 X 10 P.T.

— P.T. 2 X 4 @ 8" O.C. W 2 -I/2"\$ S.S. CARRIAGE BOLTS


P.T. 2 X 6 ---

`— 2 X Ю Р.Т.

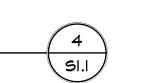

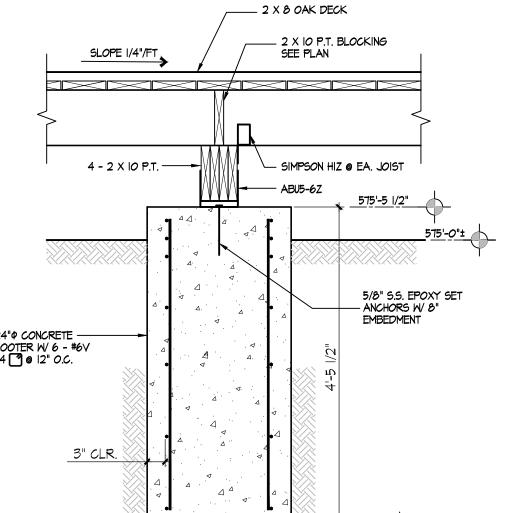

SI.I

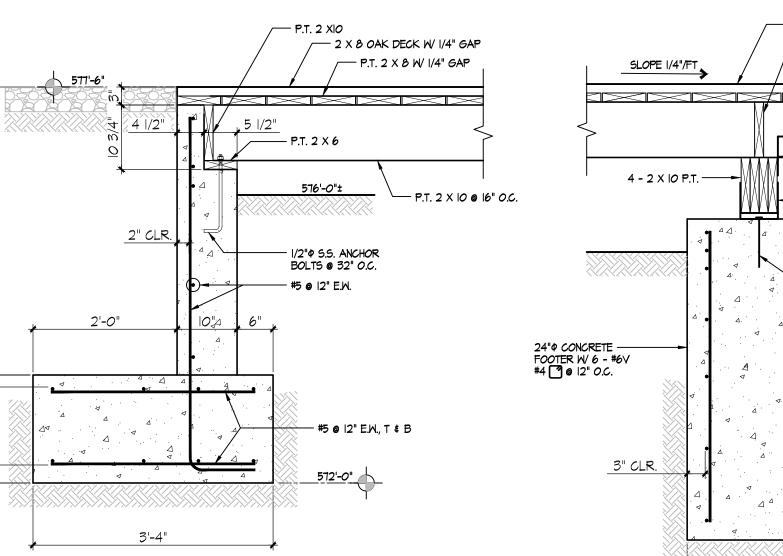

DETAIL SCALE 3/4" = 1'-0"

-2 X 10 BLOCKING

2 SI.I

P.T. 2 X 10 BLOCKING DETAIL STREAM DECK PLAN DETAIL SI.I SI.I SCALE 3/4" = 1'-0" SCALE 1/4" = 1'-0" SCALE 3/4" = 1'-0"

ELEVATION

SCALE 1/4" = 1'-0"



or Fax:

email:

Borough of Chambersburg

A full service municipality in Franklin County celebrating over 65 years of consumer owned natural gas service over 120 years of community electric and a regional wastewater, water, and municipal solid waste utility

NOTICE OF RECEIPT

I have received the Addendum No. 1 for the Conococheague Creek Canoe/Kayak Launch and Fishing Dock Project.

	Company
	Contact Person
	Date Received
Mail to:	Penny Morrison
	Borough of Chambersburg
	100 South Second Street

Chambersburg, PA 17201

utilitysecretary@chambersburgpa.gov

717-264-0224

Company